# RESIDENTIAL TREATMENT FACILITY NORTH

STANWOOD, WA 98292

**VICINITY MAP** 

#### 

SCALE: NTS

ABB	REVIATIONS				
AC APPROX APWA	ACRE APPROXIMATELY AMERICAN PUBLIC	G GRVL GV	GAS GRAVEL GAS VALVE	R RCW ROW RT	RADIUS REVISED CODE OF WASHINGTON RIGHT-OF-WAY RIGHT
ARCH ASPH ASTM AVE	WORKS ASSOCIATION ARCHITECTURAL ASPHALT AMERICAN SOCIETY FOR TESTING AND MATERIALS AVENUE	H HDPE HMA HORIZ	HEIGHT HIGH DENSITY POLYETHYLENE HOT MIX ASPHALT HORIZONTAL	S SC SCH SD	SOUTH STORM CEPTOR SCHEDULE STORM DRAIN
BLDG BMP BG	BUILDING BEST MANAGEMENT PRACTICE BOTTOM OF GRADE	ID IE IN	INSIDE DIAMETER INVERT ELEVATION INCH	SDMH SDR SF SPECS	STORM DRAIN STORM DRAIN MANHOLE STANDARD DIMENSION RATIO SQUARE FEET SPECIFICATIONS
BTM BW	BOTTOM OF PIPE BOTTOM OF WALL	L LAT LF	LENGTH LATITUDE LINEAR FEET	SQ YD SS SSCO	SQUARE YARD SANITARY SEWER SANITARY SEWER CLEANOUT
Ç CB CF	CENTERLINE CATCH BASIN CUBIC FEET	LON LT	LONGITUDE LEFT	ST STA STD	STREET STATION STANDARD
CI CL CMP CO CONC CPEP	CAST IRON CLASS CORRUGATED METAL PIPE CLEAN OUT CONCRETE CORRUGATED POLYETHYLENE PIPE	MAX MH MIN MISC MJ MON	MAXIMUM MANHOLE MINIMUM MISCELLANEOUS MECHANICAL JOINT MONUMENT	SWPPP  T TC TEMP TESC	STORM WATER POLLUTION PREVENTION PLAN  TELEPHONE TOP OF CURB TEMPORARY TEMPORARY EROSION &
CR CSTC	CROWN OF PIPE CRUSHED SURFACING TOP COURSE	N NC NO.	NORTH NO CURB NUMBER NOT TO SCALE	TG TP TW	SEDIMENT CONTROL TOP OF GRADE TOP OF PAVEMENT TOP OF WALL
DEPT DI	DEPARTMENT DUCTILE IRON	NTS OC	ON CENTER	TYP UG	TYPICAL
E EA EC EG	EAST EACH EXTRUDED CURB	OD OFF PC	OUTSIDE DIAMTER OFFSET POINT OF CURVATURE	UIC U.O.N. UP	UNDER GROUND UNDER GROUND INJECTION CONTROL UNLESS OTHERWISE NOTED UTILITY POLE
EG ELEV EP	EXISTING GRADE ELEVATION EDGE OF PAVEMENT	PCC Pl	POINT OF COMPOUND CURVE POINT OF INTERSECTION	V	VERTICAL
ESC EXIST	EROSION & SEDIMENT CONTROL EXISTING	PRC.	PROPERTY LINE POWER POLE POINT OF REVERSE CURVE	W W/ WAC	WEST WITH
FFE FG FH FL	FINISH FLOOR ELEVATION FINISHED GRADE FIRE HYDRANT	PROP PT PVC PVMT	PROPOSED POINT OF TANGENCY POLYVINYL CHLORIDE PAVEMENT	WSDOT WV	WASHINGTON ADMINISTRATIVE CODE WASHINGTON STATE DEPARTMENT OF TRANSPORTATION WATER VALVE
I L	FLANGED			YD	YARD DRAIN

## SURVEY INFORMATION

LOTS 1 AND 2 OF SHORT PLAT NO. ZA9007384SP RECORDED UNDER AUDITOR'S FILE NUMBER 9106140048, RECORDS OF SNOHOMISH COUNTY, WASHINGTON, BEING A PORTION OF THE NORTHEAST QUARTER OF SECTION 18, TOWNSHIP 32 NORTH, RANGE 4 EAST, W.M.

EXCEPT THAT PORTION DESCRIBED AS FOLLOWS:

BEGINNING AT THE SOUTHWEST CORNER OF LOT 2 OF SHORT PLAT ZA9007384SP, BEING ALSO THE NORTHEAST CORNER OF THE SOUTH198.00 FEET OF THE NORTHEAST QUARTER OF THE NORTHEAST QUARTER OF SECTION 198, TOWNSHIP 32 NORTH, RANGE 4 EAST, W.M.;

LESS THE WEST 30.00 FEET THEREOF;

THENCE NORTH 01° 13'02" EAST ALONG THE WEST BOUNDARY A DISTANCE OF 19.64 FEET TO AN EXISTING WOOD FENCE;

THENCE SOUTH 87°48'17" EAST ALONG SAID FENCE A DISTANCE OF 610.22 FEET;

THENCE SOUTH 87°56'04" EAST ALONG SAID FENCE A DISTANCE OF 610.31 FEET TO A POINT ON THE EAST BOUNDARY OF SAID SUBDIVISION, BEING 12.38 FEET NORTH OF THE NORTH LINE OF THE SOUTH 198.00 FEET OF SAID SUBDIVISION;

THENCE SOUTH 00°21'31" WEST ALONG THE EAST LINE OF SAID SUBDIVISION A DISTANCE OF 12.28 FEET TO THE NORTH LINE OF THE SOUTH 198.00 FEET OF SAID SUBDIVISION;

THENCE NORTH 88°12'55" WEST ALONG THE NORTH LINE OF SAID SOUTH 198.00 FEET A DISTANCE OF 1220.62FEET TO THE POINT OF BEGINNING.

SITUATE IN THE COUNTY OF SNOHOMISH, STATE OF WASHINGTON.

## LEGAL DESCRIPTION

LEGAL DESCRIPTION IS FROM ALTA SURVEY RECORD UNDER AUDITOR'S FILE NUMBER 201110255005. NO TITLE REPORT OR SUBDIVISION GUARANTEE WAS ORDERED OR PROVIDED FOR THIS SURVEY.


## BASIS OF BEARING

BASIS OF BEARING: PREVIOUS ALTA SURVEY ALONG THE NORTH QUARTER SECTION LINE, RECORDED UNDER AUDITOR'S FILE NUMBER 201110255005. BEARING S 87°58'34" E

#### **VERTICAL DATUM**

DATUM: NAVD88 FROM RTK GPS

DATUM CONVERSION: NAVD88(FT) - 3.67 FT = NGVD29(FT)

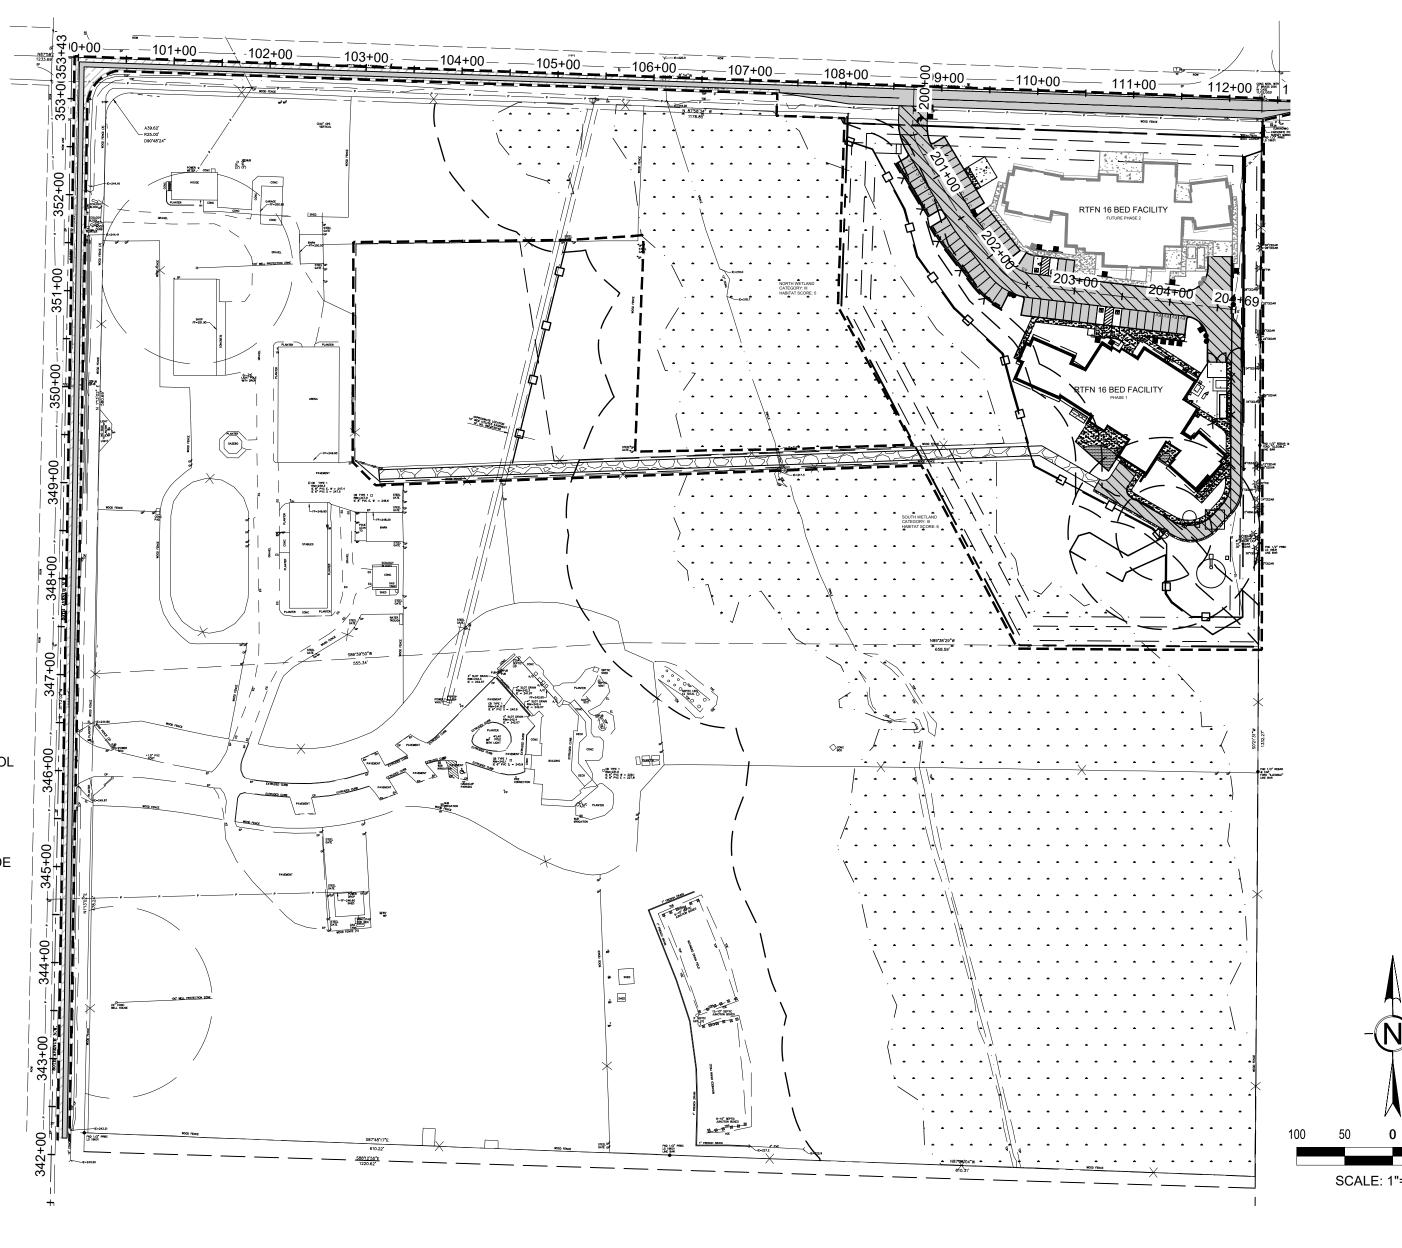

## CUP BOUNDARY PER PROJECT FILE NO: 22 104576 BLA

LOT 1 OF SHORT PLAT NO. ZA9007384SP RECORDED UNDER AUDITOR'S FILE NUMBER 9106140048, RECORDS OF SNOHOMISH COUNTY, WASHINGTON, BEING A PORTION OF THE NORTHEAST QUARTER OF SECTION 18, TOWNSHIP 32 NORTH, RANGE 4 EAST, W.M.

EXCEPT THAT PORTION OF SAID LOT 1, LYING WEST OF THE FOLLOWING DESCRIBED LINE;

COMMENCING AT A POINT ON THE LINE COMMON TO LOT 1 AND LOT 2, POINT BEARING NORTH 89°38'29" WEST, 249.06 FEET FROM THE SOUTHEAST CORNER OF LOT 1 AND THE NORTHEAST CORNER OF LOT 2; THENCE NORTH 27°41'00" WEST, 399.44 FEET;

THENCE NORTH 2°01'26" EAST, 195.27 FEET MORE OR LESS TO A POINT BEARING NORTH 87°58'34" WEST, 431.36 FEET FROM THE NORTHEAST CORNER OF SAID LOT 1, AND POINT BEING 35 FEET SOUTH OF THE NORTH LINE OF SAID NORTHEAST QUARTER, AND TERMINUS OF SAID LINE.

SITUATE IN THE COUNTY OF SNOHOMISH, STATE OF WASHINGTON.

SHEET INDEX					
NO.	SHEET	TITLE			
1	C-001	COVER SHEET			
2	C-002	GENERAL NOTES			
3	1 of 4	TOPOGRAPHIC SURVEY			
4	2 OF 4	TOPOGRAPHIC SURVEY			
5	3 OF 4	TOPOGRAPHIC SURVEY			
6	4 OF 4	TOPOGRAPHIC SURVEY			
7	C-101	DEMOLITION AND TESC PLAN			
8	C-200	OVERALL SITE PLAN			
9	C-201	SITE AND SURFACING PLAN			
10	C-301	GRADING AND DRAINAGE PLAN			
11	C-302	SITE SECTIONS			
12	C-401	UTILITY PLAN WEST			
13	C-402	UTILITY PLAN EAST			
14	C-501	EROSION CONTROL DETAILS			

#### CONTACTS:

TULALIP TRIBES OF WASHINGTON PHONE: 360.716.4210 CONTACT: JULIA GOLD EMAIL: JGOLD@TULALIPTRIBES-NSN.GOV

OWNER REPRESENTATIVE WENAHA GROUP CONTACT: KELSEY EDWARDSON

ARCHITECT BCRA **CONTACT: JIM WOLCH** PHONE: 253.627.4367 EMAIL: JWOLCH@BCRADESIGN.COM

**CIVIL ENGINEER CONTACT: ZACHARY CRUM** PHONE: 253.627.4367 EMAIL: ZCRUM@BCRADESIGN.COM

LANDSCAPE ARCHITECT PHONE: 253.627.4367 EMAIL: ESTREEBY@BCRADESIGN.COM

SEMRAU ENGINEERING AND SURVEYING, PLLC CONTACT: JOHN SEMRAU PHONE: 306.424.9566 EMAIL: JOHN@SEMRAU.COM

> REPLACED HARD SURFACE

> > AREA OF

DISTURBANCE

SCALE: 1"=100'

SITE AREAS					
DESECRIPTION	PHASE 1 QUANTITY	PHASE 2 QUANTITY	TOTAL QUANTITY		
NEW PGHS	32,467 SF	0 SF	32,467 SF		
REPLACED PGHS	1,436 SF	0 SF	1,436 SF		
NEW & REPLACED PGHS	33,903 SF	0 SF	33,903 SF		
NEW NPGHS	24,693 SF	22,135 SF	46,828 SF		
REPLACED NPGHS	0 SF	0 SF	0 SF		
NEW & REPLACED NPGHS	24,693 SF	22,135 SF	46,828 SF		
NEW HARD SURFACE	57,160 SF	22,135 SF	79,295 SF		
REPLACED	1,436 SF	0 SF	1,436 SF		

86,924 SF



80,731 SF

123,206 SF

SNOHOMISH COUNTY PROJECT FILE NO: 22 102230 CUP Call before you dig.

22,135 SF

36,282 SF

06.24.2022 DRAWN BY: RJB REVIEWED BY: ZMC SHEET TITLE

**COVER SHEET** 

**b** bcra

LAND USE SUBMITTAL

2. EXISTING TOPOGRAPHY AND BOUNDARY INFORMATION PROVIDED BY SEMRAU ENGINEERING & SURVEYING, PLLC DATED 12/17/2021.

ENGINEERING & SURVEYING, PLLC DATED 12/17/2021.
 CONTRACTORS SHALL FAMILIARIZE THEMSELVES WITH THE SITE AND SHALL BRING ANY DISCREPANCIES TO THE ATTENTION OF THE ENGINEER PRIOR TO UNDERTAKING THE

4. ANY DISCREPANCY IN THESE DRAWINGS, SPECIFICATIONS, AND/OR THE SITE CONDITIONS SHALL BE REPORTED TO THE ENGINEER, WHO SHALL ADDRESS SUCH DISCREPANCY IN WRITING AFTER REVIEWING ANY CHANGES. ANY WORK DONE BY THE CONTRACTOR AFTER THE DISCOVERY OF SUCH DISCREPANCY SHALL BE DONE AT THE CONTRACTOR'S RISK. VERIFY AND COORDINATE THE DIMENSIONS AMONG ALL DRAWINGS PRIOR TO PROCEEDING WITH ANY WORK.

5. BURIED UTILITIES ARE SHOWN IN THEIR APPROXIMATE LOCATION. PRIOR TO INSTALLATION OF ANY PROJECT IMPROVEMENTS, VERIFY LOCATION AND ELEVATION OF EXISTING UTILITIES. IN THE EVENT OF ANY DISCREPANCY FROM THE INFORMATION PRESENTED ON THESE PLANS, CONTRACTOR SHALL NOTIFY THE ENGINEER IMMEDIATELY.

A. THE LOCATION OF EXISTING UTILITIES SHOWN MAY DIFFER FROM ACTUAL LOCATION. CONTRACTOR SHOULD NOT ASSUME UTILITIES SHOWN WILL BE THE ONLY UTILITIES/OBSTACLES THAT MAY BE PRESENT ON THE SITE. VERIFY EXISTING CONDITIONS AND PROCEED WITH CAUTION AROUND ANY ANTICIPATED FEATURES. GIVE NOTICE TO UTILITY PURVEYORS REGARDING DEMOLITION AND REMOVAL OF SERVICE LINES AND CAP LINES BEFORE PROCEEDING WITH FURTHER WORK.

6. AS-BUILT RECORDS: KEEP THREE SETS OF DRAWINGS ONSITE AT ALL TIMES FOR RECORDING AS-BUILT INFORMATION. ONE SET SHALL BE PROVIDED TO THE ENGINEER AND ONE TO SNOHOMISH COUNTY AFTER CONSTRUCTION IS COMPLETE. ONE ELECTRONIC SET OF AS-BUILT DRAWINGS IN PORTABLE DOCUMENT FORMAT (PDF) MAY BE PROVIDED IN LIFT OF MILL TIPLE CODIES.

BE PROVIDED IN LIEU OF MULTIPLE COPIES.

7. AFTER CONSTRUCTION OF THE FOLLOWING ITEMS, CONTRACTOR SHALL HIRE SURVEYOR TO COLLECT AS-BUILT AND SHALL PROVIDE IN AUTOCAD AND PDF FORMAT

TO THE ENGINEER FOR REVIEW:

A.STORM AND/OR SANITARY SEWER STRUCTURE LOCATIONS (STATION AND OFFSET IF APPLICABLE) INVERT AND RIM ELEVATIONS TO THE NEAREST 0.01 FOOT.

B. DRIVEWAY/ROAD CENTERLINE AND GUTTER PROFILES AT BEGINNING AND ENDING

STATIONS AND END OF RADII.

C. WATER SYSTEM LOCATION (VALVES, FIRE HYDRANTS, ETC.) TO THE NEAREST 0.10

D. ACCESSIBLE CURB RAMPS AND ACCESSIBLE PARKING STALLS.

8. THE CONTRACTOR IS SOLELY RESPONSIBLE FOR DEVELOPING, EXECUTING AND ENFORCING A SAFETY PLAN TO PROTECT WORKERS AND THE PUBLIC FROM INJURY OR HARM. THE PLAN SHALL CONFORM TO ALL LOCAL, STATE AND FEDERAL REGULATIONS AND INCLUDE THE FOLLOWING:

A. CONTRACTOR SHALL CONSULT WITH THEIR OWN GEOTECHNICAL ENGINEERING EXPERT FOR DETERMINING SOIL CLASSIFICATION RELATIVE TO SAFE SLOPING OF

B. CONTRACTOR SHALL DETERMINE SAFE EXCAVATION AND DEWATERING METHODS, MONITOR EXCAVATIONS AND EARTHWORK OPERATIONS FOR SAFETY CONCERNS AND PROVIDE SHORING AND OTHER PROTECTION AS REQUIRED TO PROTECT WORKERS.

C.IT IS NOT THE INTENT OF THE CONSTRUCTION DOCUMENTS TO DICTATE ANY UNSAFE CONSTRUCTION MEANS OR METHODS; CONTRACTOR SHALL DETERMINE MEANS AND METHODS OF CONSTRUCTION CONFORMING TO THEIR SAFETY PLAN AS REQUIRED TO CONSTRUCT WORK SHOWN ON THE CONTRACT DOCUMENTS.

9. PROTECT THE PUBLIC AT ALL TIMES WITH FENCING, BARRICADES, ENCLOSURES, AND/OR OTHER APPROPRIATE BEST MANAGEMENT PRACTICES; COORDINATE MEASURES WITH OWNER, DEPT. OF CORRECTIONS ON-SITE REPRESENTATIVE, AND THURSTON COUNTY.

10. CONTINUOUS ACCESS SHALL BE MAINTAINED FOR THE SURROUNDING PROPERTIES AT ALL TIMES FOR THE DURATION OF THE PROJECT.

## BCRA TESC NOTES:

1. THIS PROJECT REQUIRES COVERAGE UNDER THE WASHINGTON STATE CONSTRUCTION STORMWATER GENERAL PERMIT; CONTRACTOR MUST MAINTAIN A COPY OF THE LATEST SAID PERMIT AND IS SOLELY RESPONSIBLE FOR COMPLIANCE WITH SAID PERMIT.

2. REVIEW THE STORMWATER POLLUTION PREVENTION PLAN (SWPPP) REPORT INCLUDED IN THE BID DOCUMENTS.

3. EROSION AND SEDIMENT CONTROL (ESC) MEASURES SHALL BE IN PLACE PRIOR TO THE BEGINNING OF GROUND DISTURBING ACTIVITIES.

4. ESC MEASURES ARE NOT LIMITED TO THE ITEMS SHOWN ON THESE PLANS. THE CONTRACTOR SHALL BE RESPONSIBLE FOR THE INSTALLATION AND MAINTENANCE OF ALL ESC MEASURES. SILTATION OF EXISTING OR PROPOSED DRAINAGE FACILITIES SHALL NOT BE ALLOWED.

5. THE CONTRACTOR SHALL MAKE A DAILY SURVEILLANCE OF ALL ESC MEASURES AS REQUIRED. THE CONTRACTOR SHALL PROVIDE ADDITIONAL ESC MEASURES AS DETERMINED NECESSARY BY THE PROJECT ENGINEER, OWNER OR INSPECTOR. FAILURE TO COMPLY WITH ALL LOCAL AND STATE ESC REQUIREMENTS MAY RESULT IN CIVIL PENALTIES BEING LEVIED AGAINST THE CONTRACTOR.

DURING THE WET SEASON (OCTOBER 1<sup>ST</sup> THROUGH APRIL 30<sup>TH</sup>), ALL DISTURBED SOILS SHALL BE STABILIZED WITHIN 48 HOURS AFTER STOP OF WORK. DURING THE DRY SEASON (MAY 1<sup>ST</sup> THROUGH SEPTEMBER 30<sup>TH</sup>), ALL SOILS THAT WILL BE UNCOVERED OR UNWORKED FOR 7 DAYS SHALL BE COVERED OR STABILIZED. STABILIZATION MEASURES SHALL INCLUDE, BUT ARE NOT LIMITED TO COVERING THE AFFECTED AREA (INCLUDING SPOIL PILES) WITH PLASTIC SHEETING, STRAW MATTING, JUTE MATTING, STRAW MULCH OR WOOD CHIPS. SEEDING OF THE DISTURBED AREAS SHALL TAKE PLACE AS WEATHER PERMITS.

7. TRENCH DEWATERING DEVICES SHALL BE DISCHARGED IN A MANNER THAT WILL NOT ADVERSELY AFFECT STREAMS, DRAINAGE SYSTEMS, OR OFFSITE PROPERTIES.

8. STORM SEWER INLETS RECEIVING RUNOFF FROM THE PROJECT DURING CONSTRUCTION SHALL BE PROTECTED SO THAT SEDIMENT-LADEN WATER WILL BE FILTERED BEFORE ENTERING THE CONVEYANCE SYSTEM.

9. ALL CATCH BASINS IMMEDIATELY ADJACENT TO AND DOWNSTREAM WITHIN 500 FEET OF THE PROPOSED PROJECT SITE SHALL BE PROTECTED FROM SILTATION.

10. ALL DISTURBED AREAS SHALL BE PERMANENTLY STABILIZED UPON COMPLETION OF THE WORK. THE CONTRACTOR SHALL ENSURE THAT COMPLETE COVERAGE OF THE DISTURBED AREAS IS PROVIDED AND THAT GROWTH OF THE VEGETATION IS ESTABLISHED.

#### **BCRA DEMOLITION NOTES:**

1. THE DEMOLITION SHOWN IS NOT INTENDED TO BE AN EXHAUSTIVE LIST OF ITEMS TO BE DEMOLISHED. DEMOLITION NOTES ARE FOR CLARIFICATION ONLY AND ARE SHOWN FOR THE CONTRACTOR'S BENEFIT. DEMOLISH, REMOVE AND LEGALLY DISPOSE OF ALL EXISTING IMPROVEMENTS NECESSARY TO ACCOMMODATE CONSTRUCTION OF THE PROPOSED IMPROVEMENTS. OBTAIN ALL PERMITS REQUIRED FOR DEMOLITION AND DISPOSAL.

ALL CONSTRUCTION MATERIALS SHALL BE NEW EXCEPT FOR THOSE IDENTIFIED TO BE RELOCATED ON THE PLANS. RESTORE ANY ITEMS DAMAGED DURING CONSTRUCTION TO THE PRECONSTRUCTION CONDITION.

3. REMOVE ALL EXISTING UTILITIES WITHIN 10 FEET OF THE BUILDING PAD AND BUILDING APPURTENANCES. PIPES THAT WILL SERVE NO PURPOSE WITH THIS PROPOSED PROJECT WITH MORE THAN 3' OF COVER IN THE FINAL CONDITION AND DO NOT CONFLICT WITH NEW UTILITIES, STRUCTURES, ETC. MAY BE DECOMMISSIONED AND ABANDONED IN PLACE. ABANDONED UTILITY PIPES MAY BE FILLED WITH SAND, GROUTED AND CAPPED. BACKFILL TRENCHES AND COMPACT TO 95% MAX DRY DENSITY, UNLESS OTHERWISE NOTED. OTHERWISE COORDINATE WITH UTILITY PURVEYORS TO ADDRESS CONNECTIONS AT MAINS IN ACCORDANCE WITH UTILITY PURVEYOR STANDARDS.

4. LIMITS OF DISTURBANCE MAY BE SHOWN PAST THE PROPERTY LINE FOR CLARITY. LAND DISTURBING ACTIVITY SHOULD NOT EXTEND ONTO ADJACENT PROPERTIES UNLESS OTHERWISE

#### **BCRA SITE AND SURFACING NOTES:**

 ALL DIMENSIONS ARE TO BOTTOM FACE OF CURB OR EDGE OF PAVEMENT UNLESS OTHERWISE NOTED.

2. REFER TO LANDSCAPE PLANS FOR CONCRETE JOINTING LAYOUT IN FRONT ENTRY AREA AND ENCLOSURE AREAS. ALL OTHER CONCRETE JOINTING LAYOUT SHALL BE PER CIVIL PLANS.

3. REFER TO ARCHITECTURAL PLANS FOR FENCING AND ENCLOSURE DETAILS.

4. ALL STATION OFFSETS SHOWN ON THESE PLANS REFER TO THE CONSTRUCTION ALIGNMENT IDENTIFIED ON THE PLAN.

#### **BCRA UTILITY NOTES:**

1. FIRE PROTECTION LINES AND STRUCTURES ARE SHOWN FOR BIDDING AND FOR REFERENCE ONLY.

2. FIRE PROTECTION DESIGN SHALL BE COMPLETED BY FIRE PROTECTION ENGINEER IN ACCORDANCE WITH WAC 212-80: PIPE SHALL BE DUCTILE IRON (DI) IN ACCORDANCE WITH WSDOT STD. SPEC. 7-09 WITH RESTRAINED JOINTS FOR ENTIRE LENGTH. FIRE SERVICE LINE SIZE SHALL BE VERIFIED BY CONTRACTOR'S FIRE PROTECTION ENGINEER PRIOR TO CONSTRUCTION. CONTRACTOR SHALL OBTAIN ALL REQUIRED PERMITS FOR INSTALLATION AND MODIFICATION OF THE UNDERGROUND SPRINKLER SYSTEM SUPPLY LINE BEYOND THE WATER MAIN, INCLUDING THE UNDERGROUND FIRE DEPARTMENT CONNECTION (FDC) PIPING. ALL WORK SHALL COMPLY WITH THE LATEST INTERNATIONAL FIRE CODE (IFC) AS AMENDED BY WASHINGTON STATE, SNOHOMISH COUNTY AND NFPA 24.

3. PROPOSED POWER / COMMUNICATION LINE ROUTING AND POLE LOCATIONS SHOWN FOR REFERENCE ONLY. REFER TO ELECTRICAL PLANS FOR DETAILS AND SPECIFICATIONS.

4. INSTALL PIPES IN ACCORDANCE WITH WSDOT STD. SPEC. 7-08 AND TRENCH SECTION DETAIL.

REFER TO MECHANICAL PLUMBING AND ELECTRICAL PLANS FOR HORIZONTAL AND VERTICAL LOCATION OF UTILITY STUBS FROM BUILDING.

6. PROVIDE AND TEST SANITARY SEWERS IN ACCORDANCE WITH SNOHOMISH COUNTY DEVELOPMENT STANDARDS FOR WATER AND SEWER SYSTEMS.

7. PROVIDE AND TEST WATER MAINS IN ACCORDANCE WITH SNOHOMISH COUNTY DEVELOPMENT STANDARDS FOR WATER AND SEWER SYSTEMS.

8. PROVIDE AND TEST WATER SERVICES IN ACCORDANCE WITH SNOHOMISH COUNTY DEVELOPMENT STANDARDS FOR WATER AND SEWER SYSTEMS.

#### POST CONSTRUCTION SOIL AMENDMENTS:

1. ALL AREAS DISTURBED BY CONSTRUCTION THAT DO NOT RECEIVE PAVEMENTS, CURBS, OR STRUCTURES, SHALL RECEIVE AMENDED SOILS PER THE SITE PREPARATION DETAILS ON THE LANDSCAPE PLANS. SEE SHEET L-301 DETAILS 1 THROUGH 3.

2. VEGETATION FROM CLEARING AND GRUBBING OPERATIONS MUST BE REMOVED OFF-SITE AND

DISPOSED OF IN AN APPROVED FACILITY.

3. EXISTING TOPSOIL STRIPPINGS MAY BE STOCKPILED ON-SITE WITHING THE LIMIT OF

DISTURBANCE FOR RE-USE ON-SITE ONLY IF THE CONTRACTOR SUBMITS THE FOLLOWING:

LABORATORY TESTING SHOWING THE EXISTING TOPSOILS MEET THE IMPORT TOPSOIL SPECIFICATION SECTION 32 9250.

B. IN ADDITION TO LABORATORY TESTING, CONTRACTOR SUBMITS A PLAN FOR AMENDING EXISTING TOPSOILS TO MEET THE IMPORT TOPSOIL SPECIFICATION NOTED ABOVE.

#### **BCRA STORM DRAINAGE NOTES:**

ALLOWABLE GRAVITY STORM DRAINAGE CONVEYANCE PIPES AND FITTINGS (STORM DRAIN LINE/ROOF DRAIN LINE) CONFORMING TO WSDOT STD. SPEC. 7-04. THE FOLLOWING MATERIALS MAY BE USED, UNLESS OTHERWISE IDENTIFIED SPECIFICALLY ON THE PLANS:

A.SOLID WALL PVC STORM PIPE AND FITTINGS (PVC). MINIMUM COVER SHALL BE 3.00'.

B. CORRUGATED POLYETHYLENE STORM SEWER PIPE AND FITTINGS (CPEP). MINIMUM COVER SHALL BE 2.00'.

C.DUCTILE IRON SEWER PIPE AND FITTINGS, CLASS 52 (DI). MINIMUM COVER SHALL BE 1.00'.

2. ALLOWABLE UNDERDRAIN PIPES AND FITTINGS (FOOTING DRAIN LINE) CONFORMING TO WSDOT STD. SPEC 7-01:

A. PERFORATED POLYVINYL CHLORIDE UNDERDRAIN PIPE (PERF. PVC).

3. INSTALL ALL ROOF DRAIN LINES AT MINIMUM 1.00% SLOPE WITH 3.00' MINIMUM COVER IN PAVED AREAS AND 1.50' MINIMUM COVER IN LANDSCAPE AREAS. ROOF DRAIN LINES TO BE 6" PVC UNLESS OTHERWISE NOTED.

4. ROOF AND FOOTING DRAIN LINES ARE LOCATED ON PLANS FOR CLARITY AND ARE TO BE INSTALLED IN ACCORDANCE WITH STANDARD PRACTICE AND APPLICABLE CODES.

ALL STORM DRAINAGE AND ROOF DRAIN LINE CLEANOUTS MUST COMPLY WITH THE CLEANOUT DETAIL.

6. ALL CATCH BASINS ARE TO BE SITUATED SUCH THAT THE OUTSIDE EDGE OF GRATE FRAME IS AT TOE OF CURB OR FLOW LINE OF GUTTER (WHERE APPLICABLE).

STATION AND OFFSET CALLOUTS FOR STORM ARE TO CENTER OF STRUCTURE.
 PIPE LENGTHS NOTED ON THE PLANS ARE MEASURED FROM CENTER OF STRUCTURE TO

CENTER OF STRUCTURE.

9. INSTALL ALL STORM DRAINAGE CATCH BASINS AND MANHOLES IN PAVED AREAS FLUSH WITH PAVEMENT. MANHOLES IN UNPAVED AREAS SHALL BE 6" ABOVE FINISHED GRADE.

LIDS SHALL BE LABELED "STORM."

10. PROVIDE CATCH BASINS AND MANHOLES IN ACCORDANCE WITH WSDOT STD. SPEC. 7-05.

11. PROVIDE, INSTALL AND TEST ALL STORM DRAINAGE SYSTEMS IN ACCORDANCE WITH WSDOT STD. SPEC. 7-04 AND THE TRENCH SECTION DETAIL.

#### BCRA GRADING NOTES:

1. ADA COMPLIANCE:

A. SHALL BE IN ACCORDANCE WITH CFR 28, PART 35;

B. FOR WORK IN THE RIGHT-OF-WAY, CFR 28, PART 35 SHALL BE SUPPLEMENTED BY THE PUBLIC WORKS RIGHTS OF WAY ACCESSIBILITY GUIDELINES (PROWAG);

C.ALL SITE IMPROVEMENTS SUBJECT TO THE AMERICAN WITH DISABILITIES ACT (ADA) STANDARDS FOR ACCESSIBLE DESIGN SHALL MEET THE FOLLOWING MAXIMUM SLOPES. IT IS THE SOLE RESPONSIBILITY OF THE CONTRACTOR TO REMOVE AND REPLACE IMPROVEMENTS OUT OF COMPLIANCE WITH THE ADA STANDARDS.

THE FOLLOWING MAXIMUM SLOPES SHALL NOT BE EXCEEDED UNLESS NOTED ON THE PLAN AS A "MAXIMUM EXTENT FEASIBLE" (MEF) LOCATION:

A.LONGITUDINAL/RUNNING SLOPE OF WALKWAYS AND CROSSWALKS: 5.00%

B. CROSS SLOPE OF SIDEWALK: 2.00%

C.LONGITUDINAL/RUNNING SLOPE OF RAMP: 8.33%

D.CROSS SLOPE OF RAMP: 2.00%

E.LONGITUDINAL/RUNNING SLOPE OF LANDING: 2.00%

F. CROSS SLOPE OF LANDING: 2.00%

G.TOP OF CURB SLOPE AT RAMP FLARE: 10.00%

H. FLOW LINE SLOPE AT PEDESTRIAN CROSSING: 2.00%

I. ADA PARKING STALL: 2.00% IN ANY DIRECTION

J. ADA PARKING ACCESS AISLE: 2.00% IN ANY DIRECTION


2. REFER TO GEOTECHNICAL ENGINEERING REPORT BY SEMRAU ENGINEERING & SURVEYING, PLLC DATED 12/17/2021 FOR INFORMATION ON EXISTING SITE CONDITIONS AS WELL AS SITE AND SOIL REQUIREMENTS FOR THIS PROJECT.

3. THE SPOT ELEVATIONS INDICATED ON THIS PLAN REPRESENT THE DESIGN TOP OF PAVEMENT UNLESS OTHERWISE NOTED.

 PROVIDE POSITIVE DRAINAGE AWAY FROM BUILDINGS FOR ALL NATURAL AND PAVED AREAS AND GRADE ALL AREAS TO PRECLUDE PONDING OF WATER.

5. ADJUST ALL EXISTING MANHOLE RIMS, DRAINAGE STRUCTURES, VALVE BOXES, VAULT LIDS AND UTILITY ACCESS STRUCTURES THAT WILL BE PRESERVED TO FINISHED GRADE WITHIN AREAS AFFECTED BY CONSTRUCTION.

25.3 627 4367 E 25.3 627 4395 WWW BCRADESIGN COM

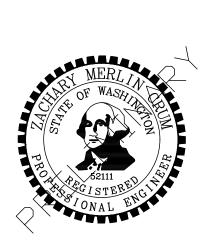

ESIDENTIAL TREATMENT FACILITY NORTH

REVISIONS

PATE

06.24.2022

SHEET TITLE

GENERAL NOTES

DESIGNED BY: MB

21031

DRAWN BY: RJB

REVIEWED BY: ZMC

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C-002





ESIDENTIAL 901 & 29919 80TH AVE NW ANWOOD, WA 98292

PRO	$\overline{\mathbf{C}}$	299( STA	
REVISIONS	<u> </u>		
DATE			
06.24.	2022		

21031

DRAWN BY: RJB REVIEWED BY: ZMC SHEET TITLE

DEMOLITION AND TESC PLAN

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LAND USE SUBMITTAL

SNOHOMISH COUNTY PROJECT FILE NO: 22 102230 CUP

Know what's below.

SITE AND SURFACING LEGEND

SETBACK LINE ROAD CENTERLINE **BUILDING FOOTPRINT** ASPHALT PAVEMENT CEMENT CONCRETE SIDEWALK CEMENT CONCRETE PAVEMENT GRAVEL SURFACING CEDAR SPLIT RAIL FENCE NUMBER OF PARKING STALLS PER PRECAST CONCRETE WHEELSTOP

LIMITS OF GRADING

### SITE INFORMATION

- SITE AND ALL ADJACENT SITES ARE DESIGNATED FEMA FLOOD
- NOT A CRITICAL AREA SITE PLAN. • NOT LOCATED WITHIN A CRITICAL AQUIFER RECHARGE AREA.
- PARKING REQUIREMENTS DETERMINED BY THE DEPARTMENT BASED ON COMPARABLE USES.
- ZONING: R-5

**PROJECT PARKING REQUIREMENTS:** 

STANDARD STALLS: 28 PER BUILDING 2 PER BUILDING 60 STALLS

PARCEL AREA AFTER BLA 200,760 SF BUILDING FOOTPRINT AREAS 0.80 AC EXISTING IMPERVIOUS SURFACE 0.03 AC

CUT/FILL SUMMARY


8,500 CY FILL 10,000 CY 1,500 CY <FILL>

TAX PARCEL: 32041800100100 SECTION 18, TOWNSHIP 32 NORTH, RANGE 4 EAST

LIMITS OF WORK GENERAL

## NOTE:

LIMITS OF WORK ARE SHOWN AT PROPERTY LINE FOR WETLAND BUFFER AND PERIMETER BUFFER PLANTINGS. NO GRADING OR HEAVY **EQUIPMENT OPERATION SHALL OCCUR** OUTSIDE LIMIT OF GRADING OR WITHIN MAPPED WETLANDS OR BUFFER AREAS

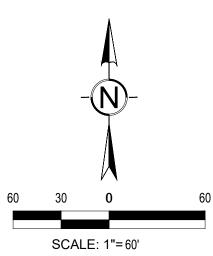



SNOHOMISH COUNTY PROJECT FILE NO: 22 102230 CUP Call before you dig.

IF SHEET MEASURES LESS THAN 24"X36", IT IS A REDUCED PRINT. REDUCE SCALE ACCORDINGLY



06.24.2022 21031


DRAWN BY: RJB REVIEWED BY: ZMC

SHEET TITLE

OVERALL SITE PLAN

**b** bcra

LAND USE SUBMITTAL

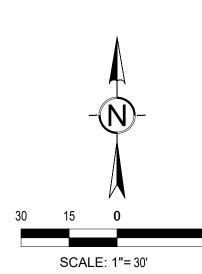



Know what's **below.** SNOHOMISH COUNTY PROJECT FILE NO: 22 102230 CUP


LAND USE SUBMITTAL

**b** bcra

06.24.2022

DRAWN BY: RJB REVIEWED BY: ZMC SHEET TITLE SITE AND

SURFACING PLAN

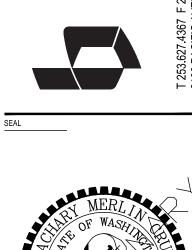



RESIDENTIAL TREATMENT FACIL

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6.24.2022	
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1021	

GRADING AND DRAINAGE PLAN

DRAWN BY: RJB
REVIEWED BY: ZMC

**1** bcra

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C-301

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Know what's below.

SCALE: SHOWN



06.24.2022

21031 DRAWN BY: RJB REVIEWED BY: ZMC SHEET TITLE

SITE SECTIONS

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ESIDENTIAL TREATMENT FACILIT

DATE

06.24.2022

D6.24.2022 CRA NO. 21031

DRAWN BY: RJB DESIGNED BY: MB
REVIEWED BY: ZMC
SHEET TITLE

UTILITY PLAN WEST

OTILITY FLAN WEST

bcra
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C-401

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06.24.2022


21031 DRAWN BY: RJB DESIGNED BY: MB REVIEWED BY: ZMC

SHEET TITLE **EROSION CONTROL** 

DETAILS

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LAND USE SUBMITTAL

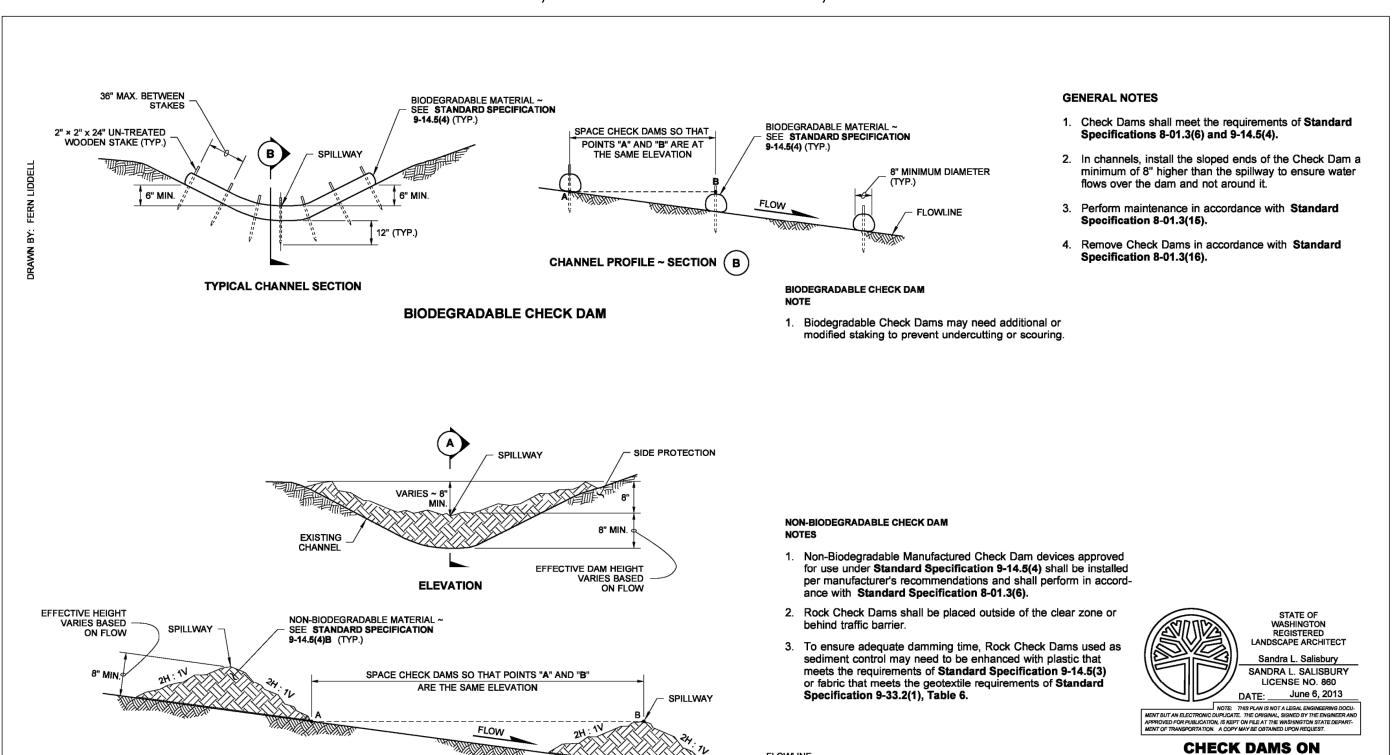

STRAW WATTLE

EXTENDED SECTION (A)

NON-BIODEGRADABLE CHECK DAM

SCALE: NTS

ROCK CHECK DAM


SCALE: NTS

**CHANNELS** 

STANDARD PLAN I-50.20-01

SHEET 1 OF 1 SHEET APPROVED FOR PUBLICATION Pasco Bakotich III 6/10/13

Vashington State Department of Transportation

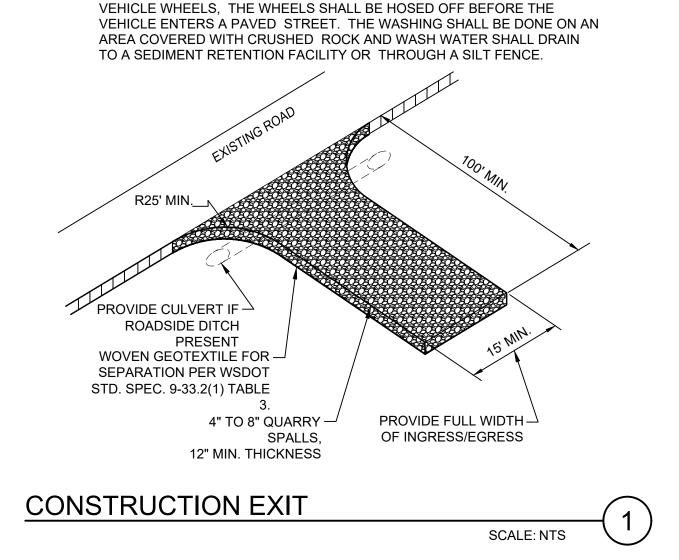

**CONSTRUCTION ENTRANCE NOTES:** 

AREA 15' MIN.

FUNCTION OF THE PAD.

1. MATERIAL SHALL BE 4-INCH TO 8-INCH QUARRY SPALLS. DO NOT USE

2. THE ROCK PAD SHALL BE AT LEAST 12 INCHES THICK AND 100 FEET LONG.

3. ADDITIONAL ROCK SHALL BE ADDED PERIODICALLY TO MAINTAIN PROPER


4. IF THE PAD DOES NOT ADEQUATELY REMOVE THE MUD FROM THE


WIDTH SHALL BE THE FULL WIDTH OF THE VEHICLE INGRESS AND EGRESS

CRUSHED CONCRETE, CEMENT OR CALCIUM CHLORIDE.

NOTE: PROVIDE TEMPORARY SEEDING PER WSDOT

TEMPORARY INTERCEPTOR SWALE SCALE: NTS

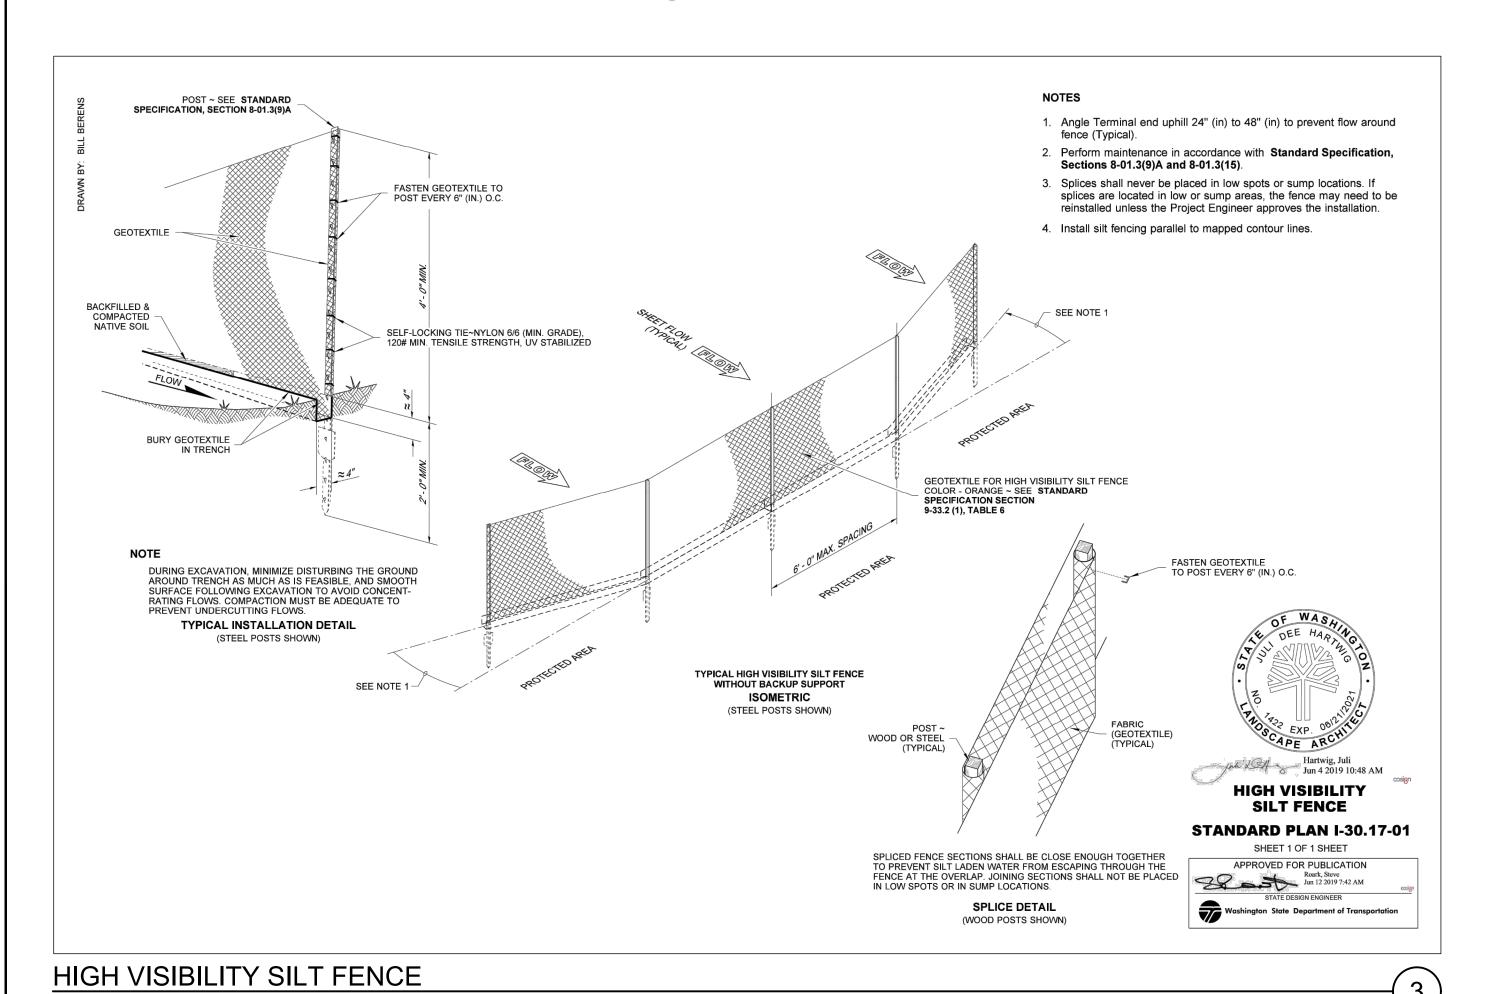

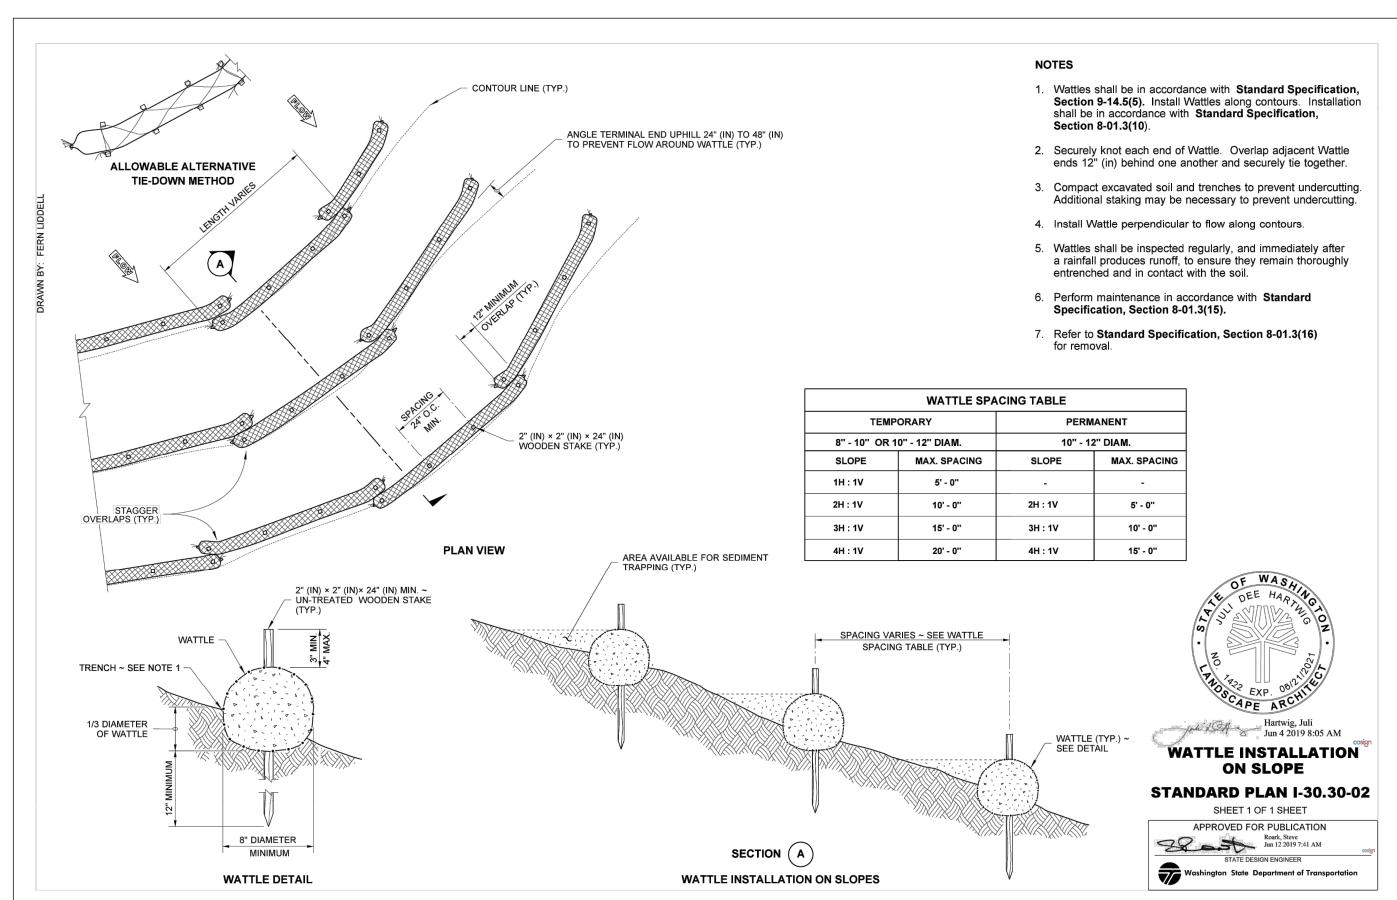

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